



FLOOR PLAN

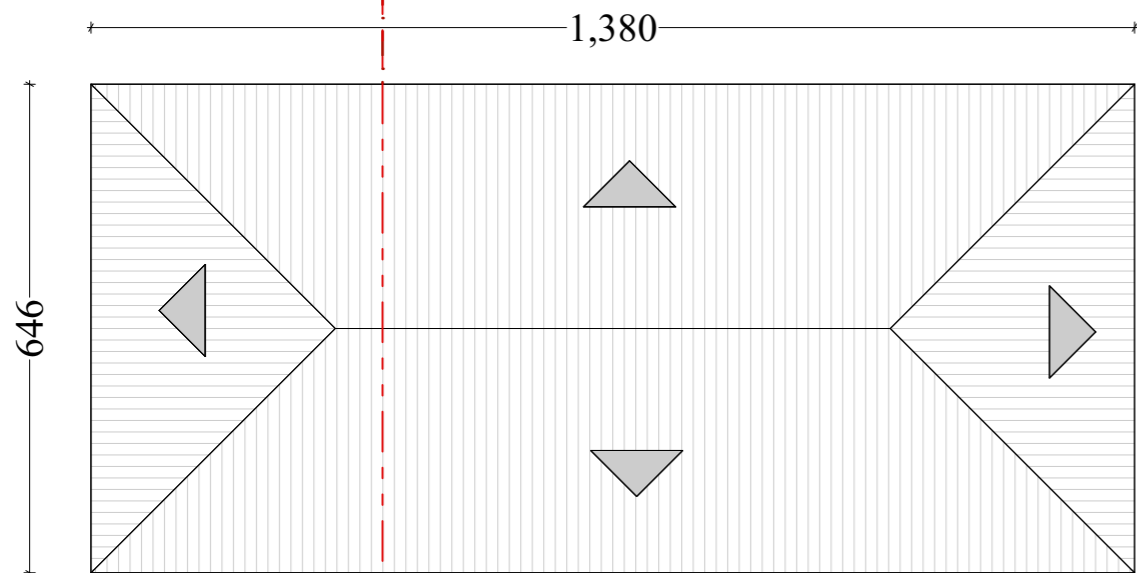

ROOF PLAN

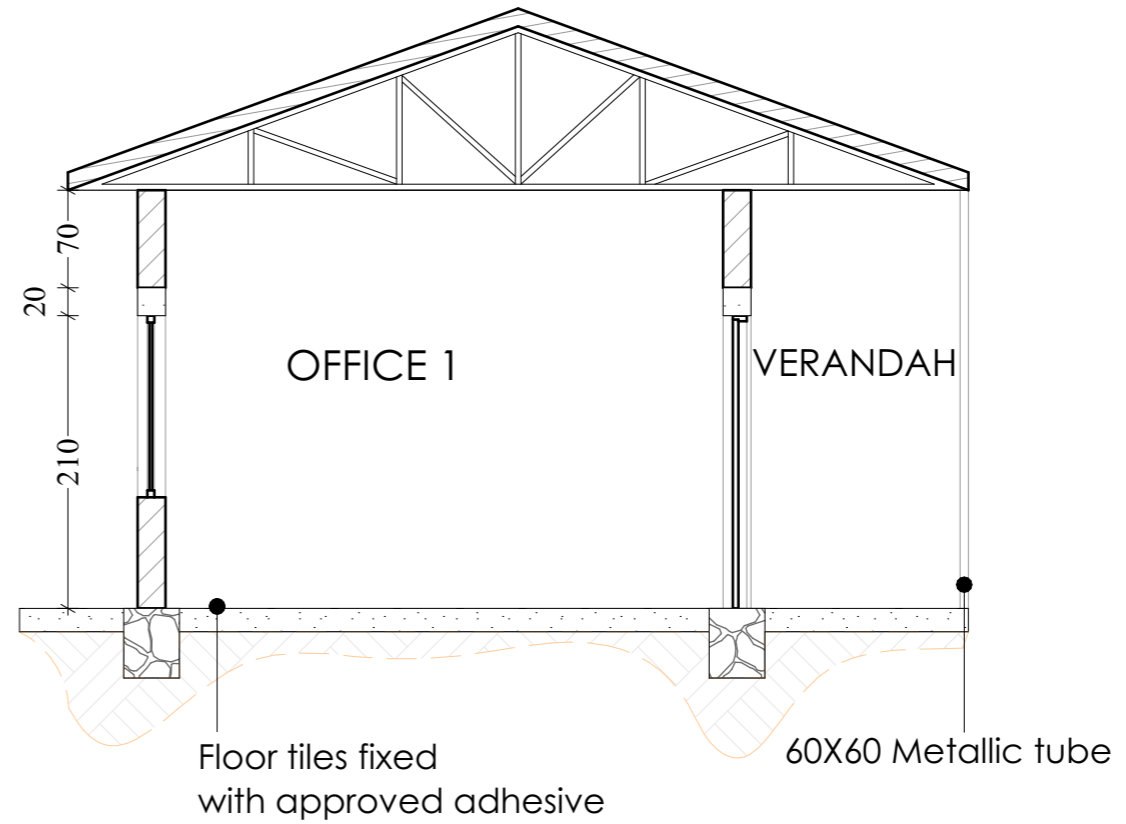

SECTION A

GENERAL CONSTRUCTION NOTES

1. This drawing is protected under the copyright act, and can not be used or produced in part or in whole without authors consent
2. Read only figured dimensions. All dimensions in meters unless otherwise stated
3. P.V. denotes permanent ventilation and be provided above all doors and windows
4. All construction work is to comply with the latest R.B.S. Standard codes of practice, Local Authority By-Laws, and fire regulations
5. Water meter to be 30cm above G.L
6. D.p.c denotes one layer of bituminous felt to be provided under all walls 15cm above G.L
7. All R.C works to structural engineer's details
8. Contractors must verify all dimensions and levels on site before begin the work. Any discrepancies must be reported to the architect before work is put in hand
9. All levels shown are finished levels unless otherwise stated
10. All surface beds to be cast on well compacted and well consolidated filling
11. Depth of foundation trenches to be determined after soil test

REVISIONS

N°	Revision/Issue	Date

PROJECT

CONSTRUCTION OF RESETTLEMENT OFFICE

DRAWING TITLE

FLOOR PLAN, ROOF PLAN, SECTION A

PROJECT STAGE

Submission for Approval

CLIENT

UNHCR


LOCATION **PLOT N°**

KIZIBA REFUGEE CAMP

CONSULTANT


Designed by Eng. Christian Mwijanda **Date** 7/27/2024
Scale As shown

Checked by Eng. Abdinoor Ibrahim Abdirahman

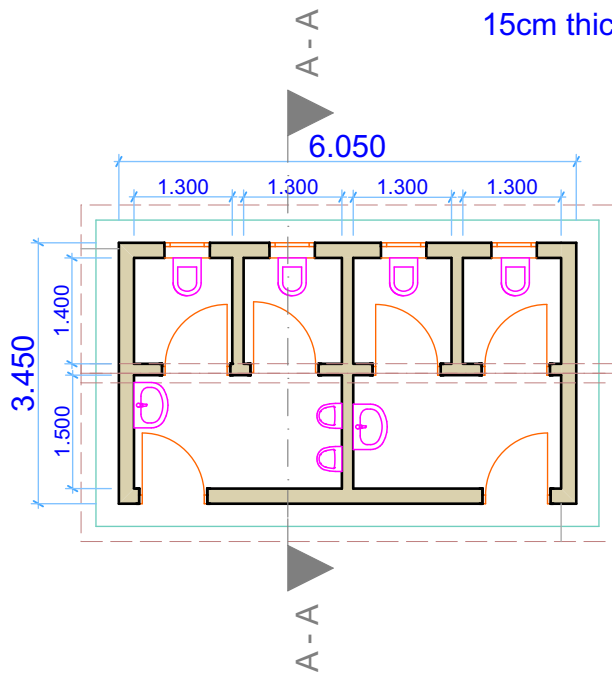

FLOOR PLAN


15cm thick partition wall

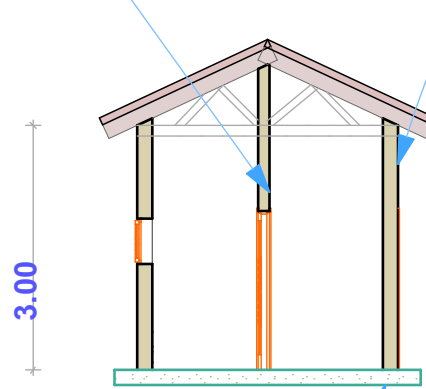


SECTION

200cm thick external wall


10cm Thick concrete slab

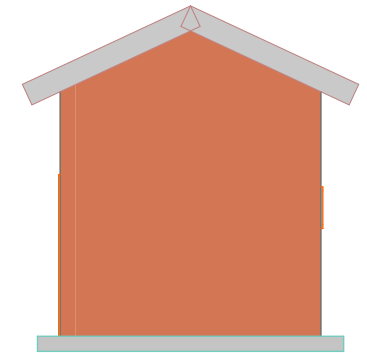


SIDE ELEVATION

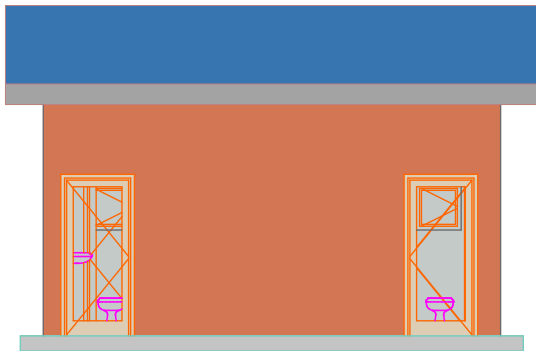

FRONT ELEVATION

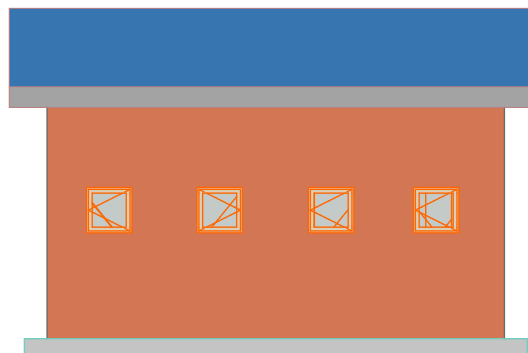


REAR ELEVATION

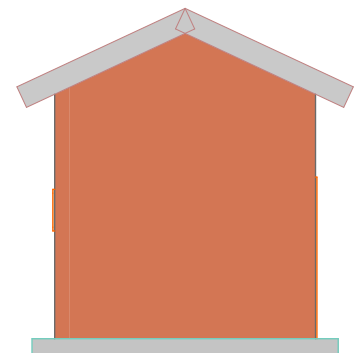


SIDE ELEVATION

KIZIBA RESETTLEMENT OFFICES WASHROOMS


KIZIBA RESETTLEMENT OFFICES WAITING AREA

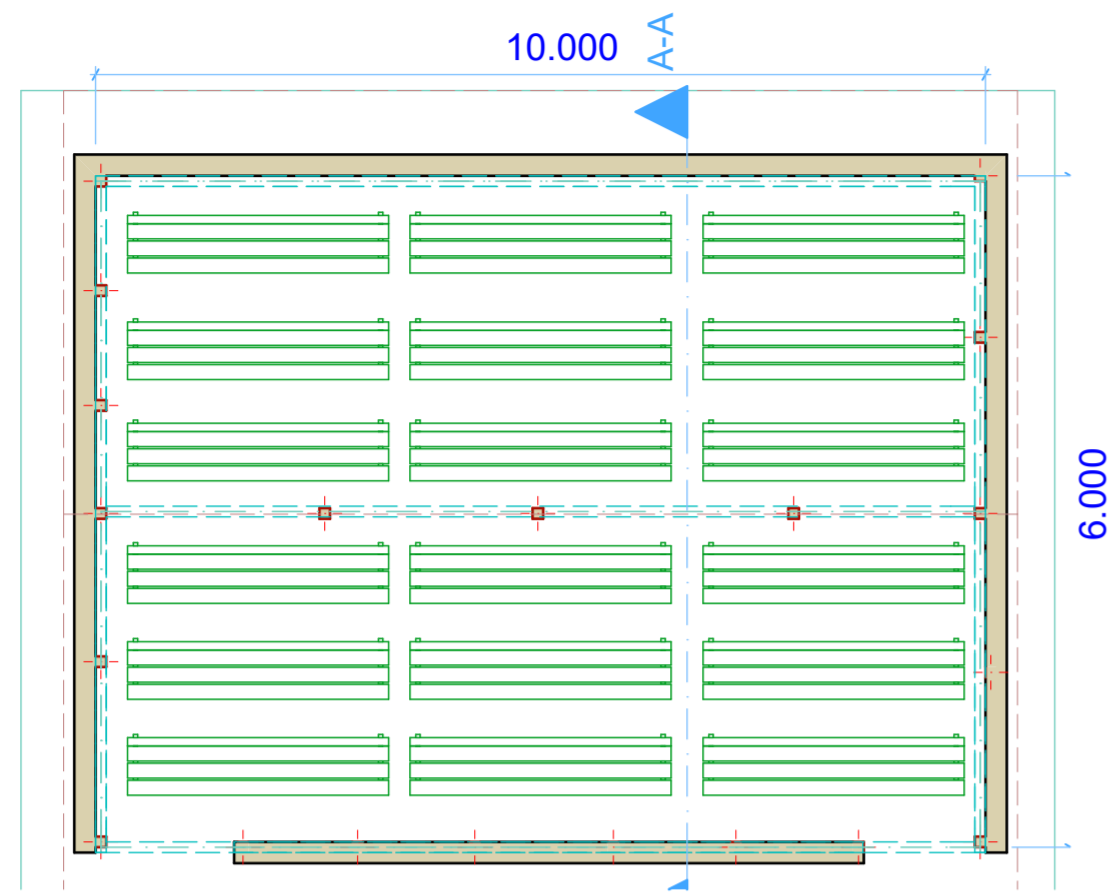


FLOORPLAN

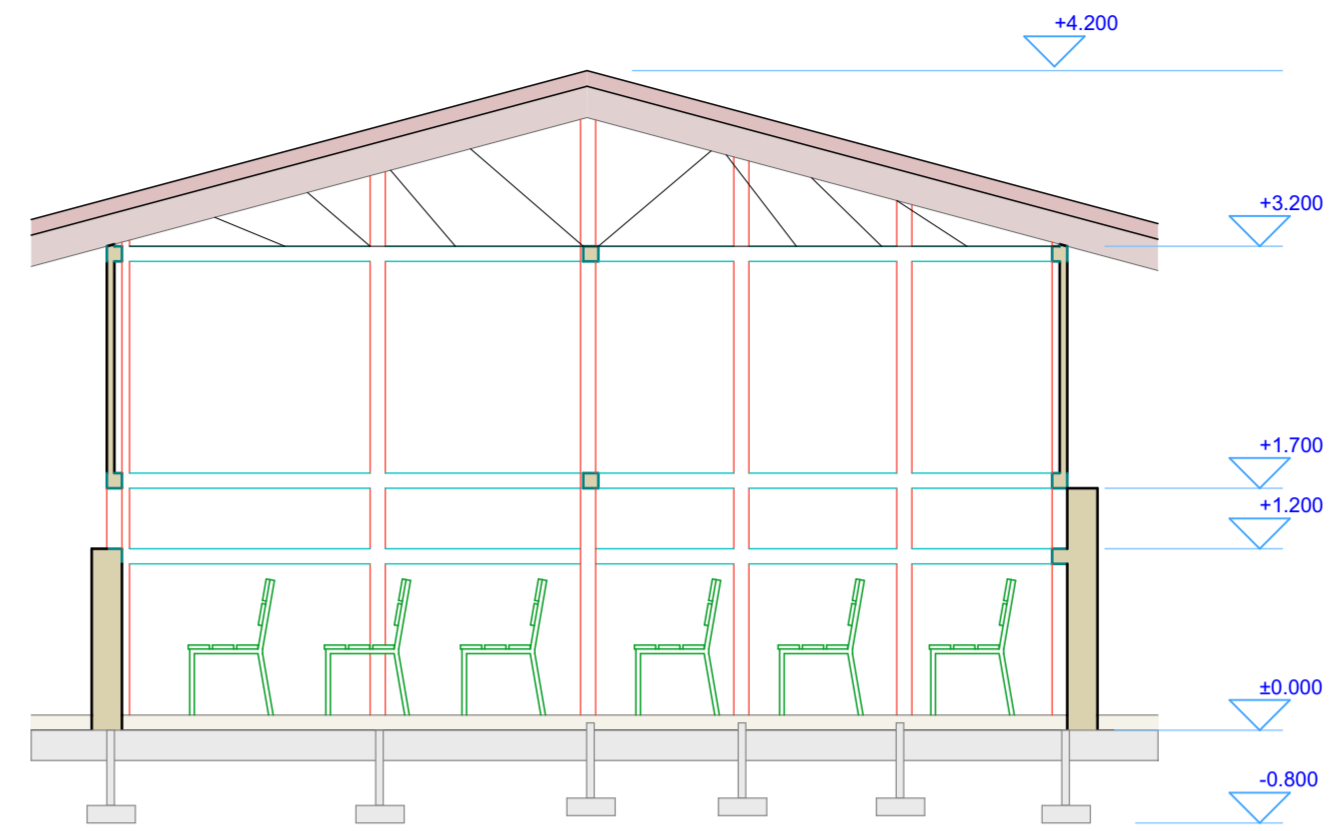


SECTION A - A

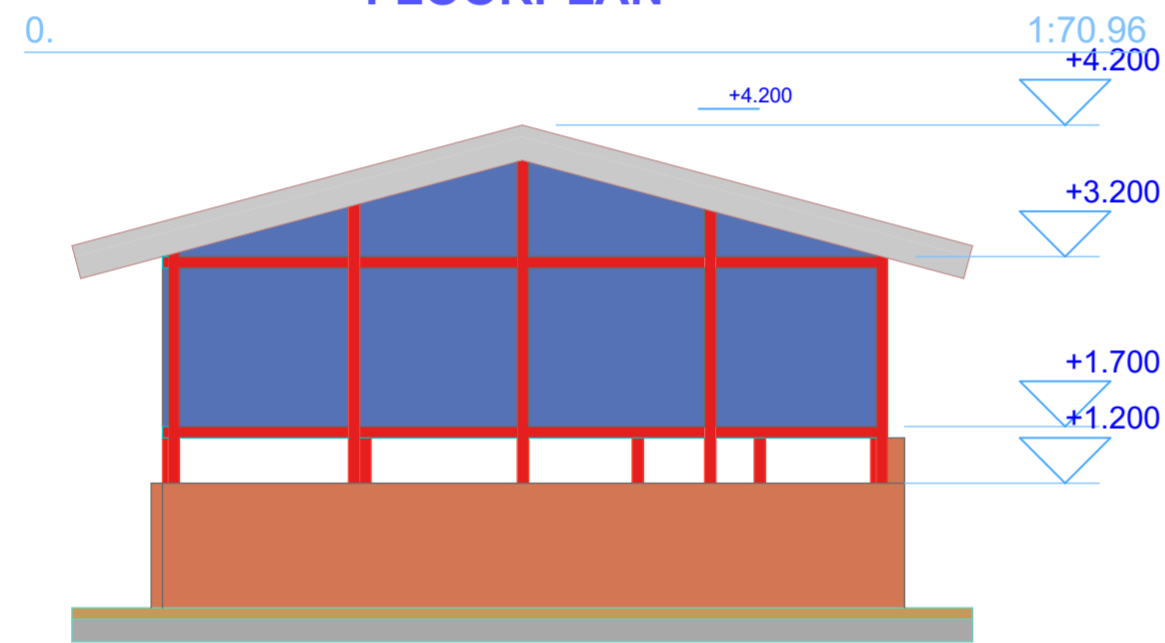

REAR ELEVATION

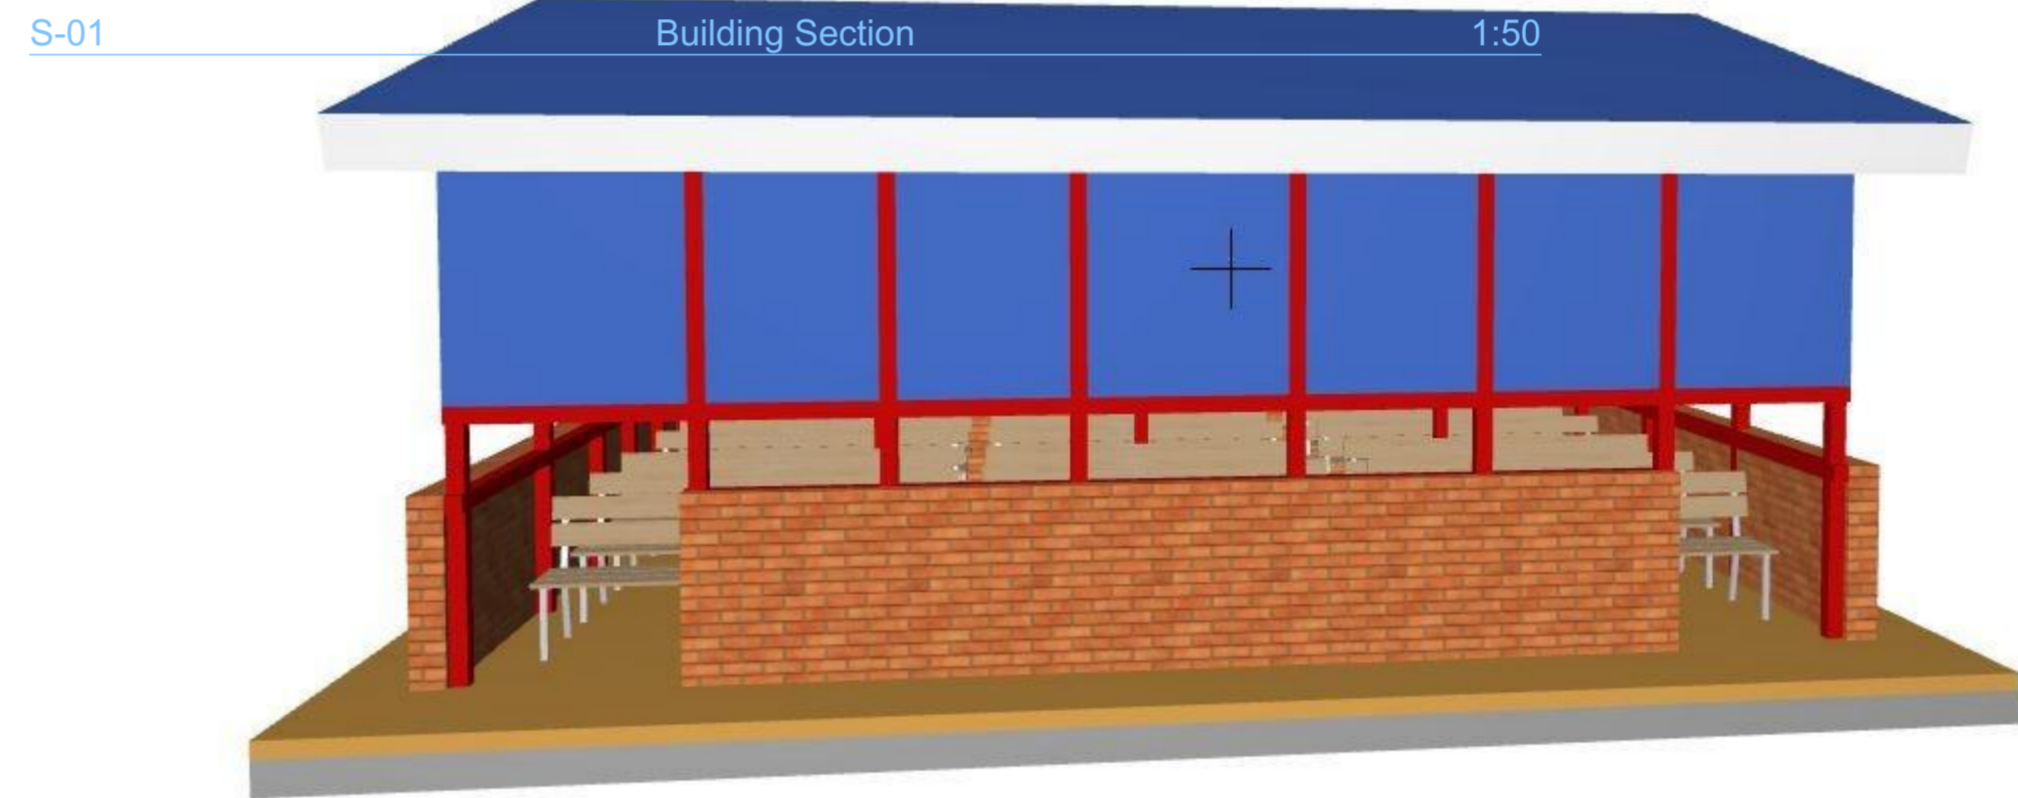



FRONT ELEVATION

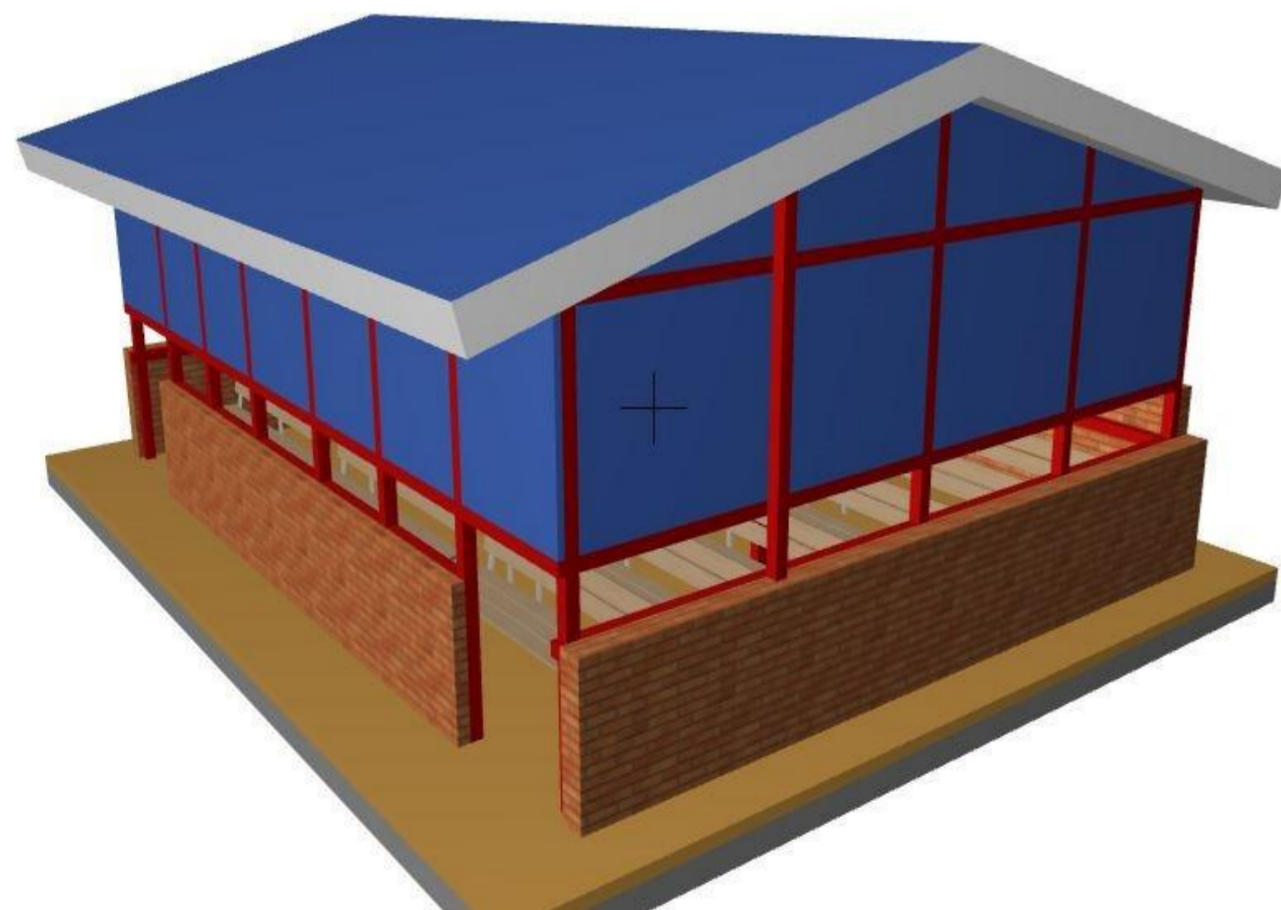

SIDE ELEVATION



TYPE	CAPACITY IN LITRES	NO. OF PERSONS	DE-SLUDGING INTERVAL (YEARS)	DIMENSIONS IN MM						
				A	B	C	D	E	F1	F2
A	3000	10	2	800	1000	1000	3000	800	1200	1400
B	6000	20	2	800	1400	1200	3600	1400	1500	1400
C	9000	30	2	800	1400	1200	3600	1800	1500	1400
D	12000	40	2	800	1600	1400	4000	2000	1500	1300
E	15000	50	2	800	1600	1400	4000	2400	1500	1200
F	22500	100	1.5	800	3600	1800	5600	3000	1850	1500
G	45000	200	1.5	800	5600	2800	8600	3600	2040	1500
H	67500	300	1.5	800	7600	3800	11600	4000	2260	1500
I	90000	400	1.5	800	8800	4400	13400	4600	2380	1500

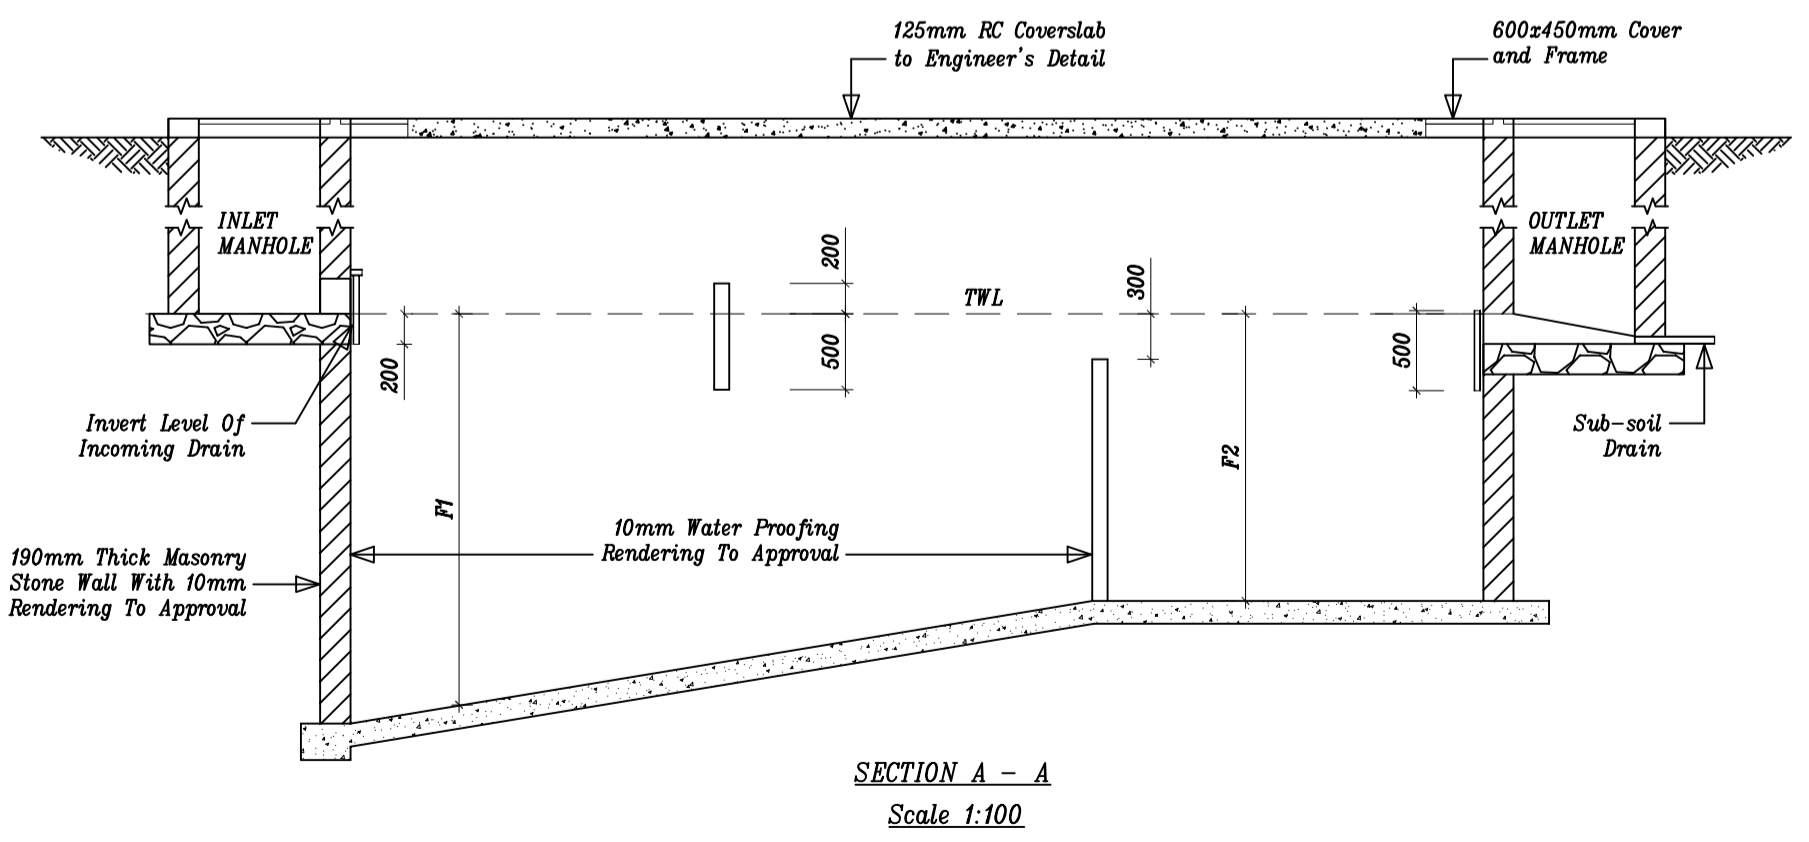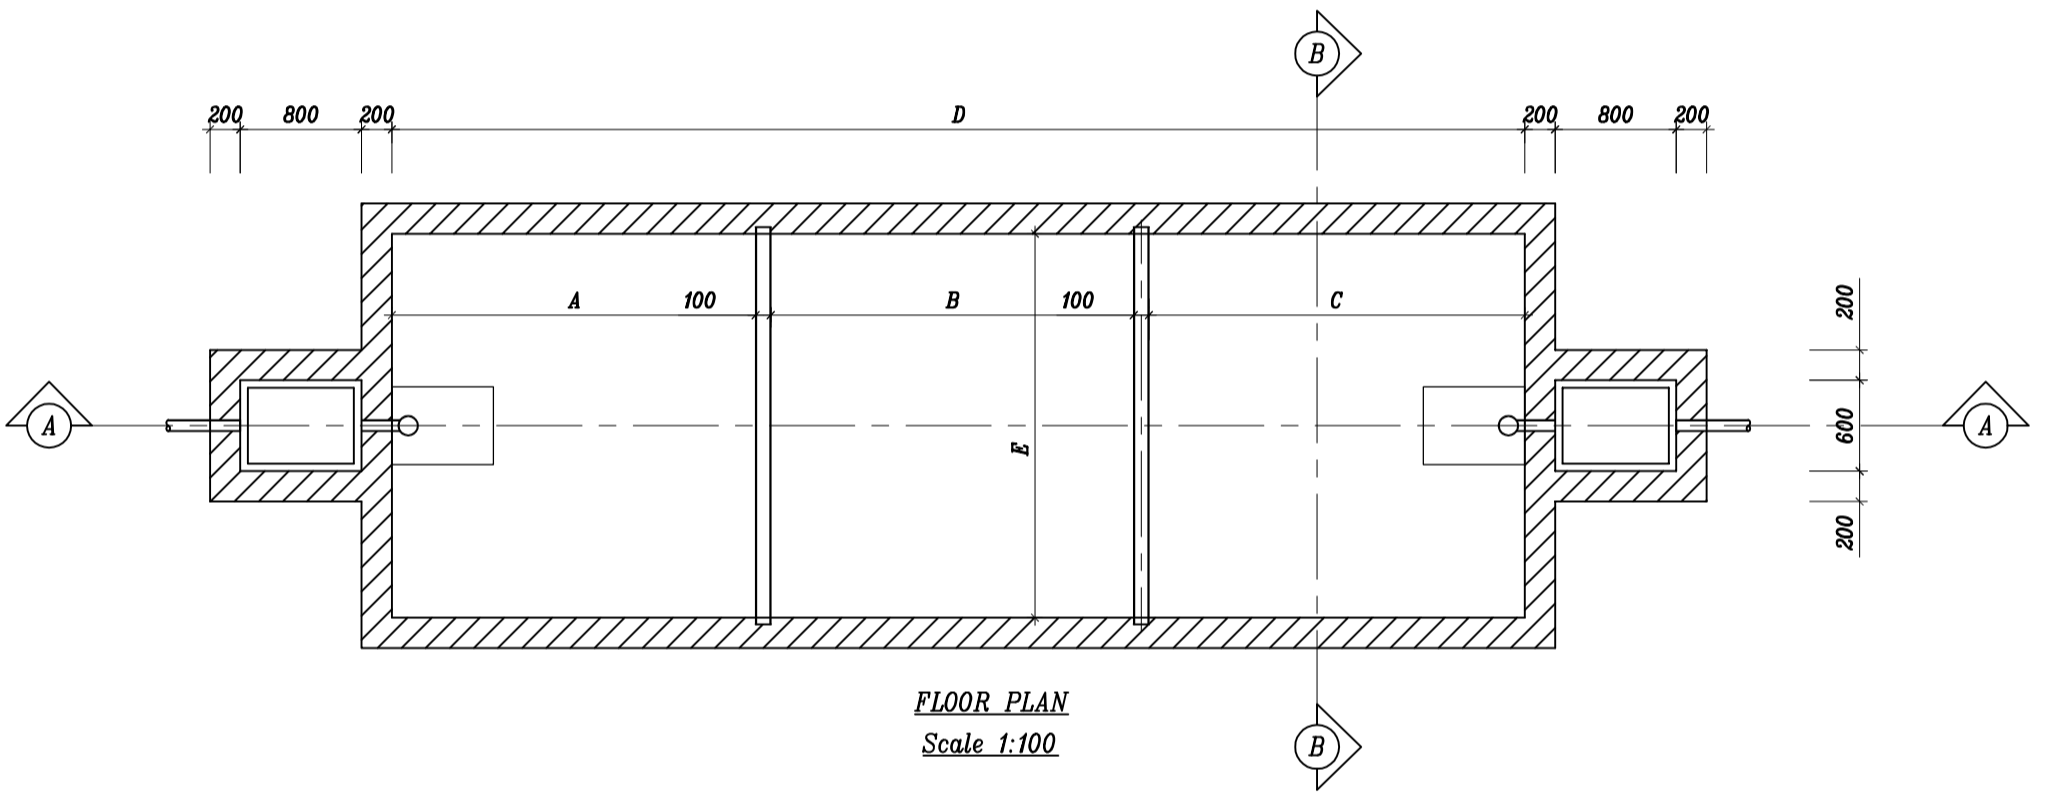

SEPTIC TANK DETAILS